


Size	Spacing In. o.c.	Dense Select Structural	Select Structural	NonDense Select Structural	No.1 Dense	No.1	No.1 NonDense	No.2 Dense	No.2	No.2 NonDense	No.3
2x4	12	7-3	7-1	6-10	7-1	6-10	6-6	6-10	6-8	6-4	5-6
	16	6-7	6-5	6-2	6-5	6-2	5-11	6-2	6-1	5-9	4-9
	24	5-9	5-8	5-5	5-8	5-5	5-2	5-4	5-1	5-0	3-11
2x6	12	11-4	11-2	10-9	11-2	10-9	10-3	10-9	10-6	10-0	8-2
	16	10-4	10-2	9-9	10-2	9-9	9-4	9-7	9-4	8-10	7-1
	24	9-0	8-10	8-6	8-10	8-6	8-2	7-10	7-7	7-3	5-9
2x8	12	15-0	14-8	14-2	14-8	14-2	13-6	14-2	13-8	13-1	10-3
	16	13-7	13-4	12-10	13-4	12-10	12-3	12-4	11-10	11-4	8-11
	24	11-11	11-8	11-3	11-5	11-0	10-6	10-0	9-8	9-3	7-3
2x10	12	19-1	18-9	18-0	18-9	18-0	17-3	16-8	16-2	15-5	12-2
	16	17-4	17-0	16-5	16-10	16-1	15-3	14-6	14-0	13-4	10-6
	24	15-2	14-11	14-4	13-9	13-1	12-6	11-10	11-5	10-11	8-7
2x12	12	23-3	22-10	21-11	22-10	21-11	20-11	20-0	19-1	18-5	14-4
	16	21-1	20-9	19-11	20-0	19-1	18-1	17-4	16-6	16-0	12-5
	24	18-5	18-1	17-5	16-4	15-7	14-9	14-2	13-6	13-0	10-2

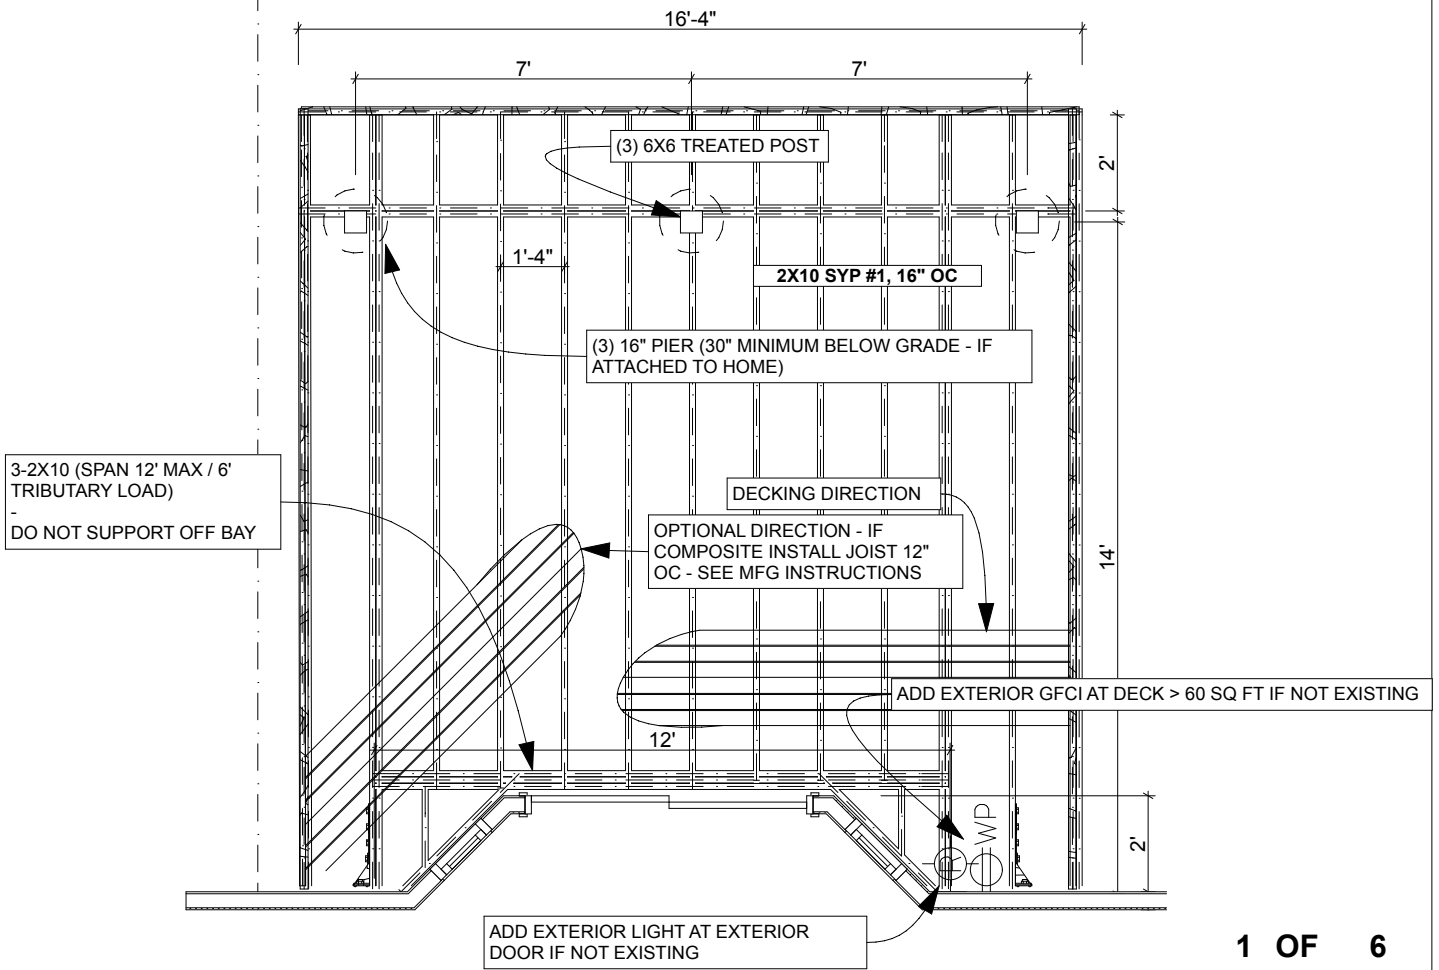


<b>Company name</b> Street City State/Country Postal Code	Drawn by <b>EXAMPLE ONLY NOT FOR CONSTRUCTION</b>	Date	Drawing Name <b>FLOOR PLAN</b>
	Checked by <b>DECK EXAMPLE # 2</b>	Date	Drawing Status <b>DECK EXAMPLE</b>
<b>Project</b> #Architect Address1 #Architect City #Architect Country #Architect Postcode			Drawing Scale <b>1/4" = 1'-0"</b>
			Layout ID      Status      Revision <b>A.01.1</b>

**TABLE R502.2.2.1**  
**FASTENER SPACING FOR A SOUTHERN PINE OR HEM-FIR DECK LEDGER**  
**AND A 2-INCH NOMINAL SOLID-SAWN SPRUCE-PINE-FIR BAND JOIST<sup>c, f, g</sup>**  
 (Deck live load = 40 psf, deck dead load = 10 psf)

JOIST SPAN	6' and less	6'1" to 8'	8'1" to 10'	10'1" to 12'	12'1" to 14'	14'1" to 16'	16'1" to 18'
	On-center spacing of fasteners <sup>d, e</sup>						
1/2 inch diameter lag screw with 1 5/32 inch maximum sheathing <sup>a</sup>	30	23	18	15	13	11	10
1/2 inch diameter bolt with 1 5/32 inch maximum sheathing	36	36	34	29	24	21	19
1/2 inch diameter bolt with 1 5/32 inch maximum sheathing and 1/2 inch stacked washers <sup>b, h</sup>	36	36	29	24	21	18	16

For SI: 1 inch = 25.4 mm, 1 foot = 304.8 mm. 1 pound per square foot = 0.0479 kPa.

- a. The tip of the lag screw shall fully extend beyond the inside face of the band joist.
- b. The maximum gap between the face of the ledger board and face of the wall sheathing shall be 1/2".
- c. Ledgers shall be flashed to prevent water from contacting the house joist.
- d. Lag screws and bolts shall be staggered in accordance with Section R502.2.2.1.1.
- e. Deck ledger shall be minimum 2x8 pressure-preservative-treated No. 2 grade lumber, or other approved materials as established by standard engineering practice.
- f. When solid-sawn pressure-preservative-treated deck ledgers are attached to a minimum 1 inch thick engineered wood product (structural composite lumber, laminated veneer lumber or wood structural panel band joist), the ledger attachment shall be designed in accordance with accepted engineering practice.
- g. A minimum 1 x 9 1/2 Douglas Fir laminated veneer lumber rimboard shall be permitted in lieu of the 2-inch nominal band joist.
- h. Wood structural panel sheathing, gypsum board sheathing or foam sheathing not exceeding 1 inch in thickness shall be permitted. The maximum distance between the face of the ledger board and the face of the band joist shall be 1 inch.

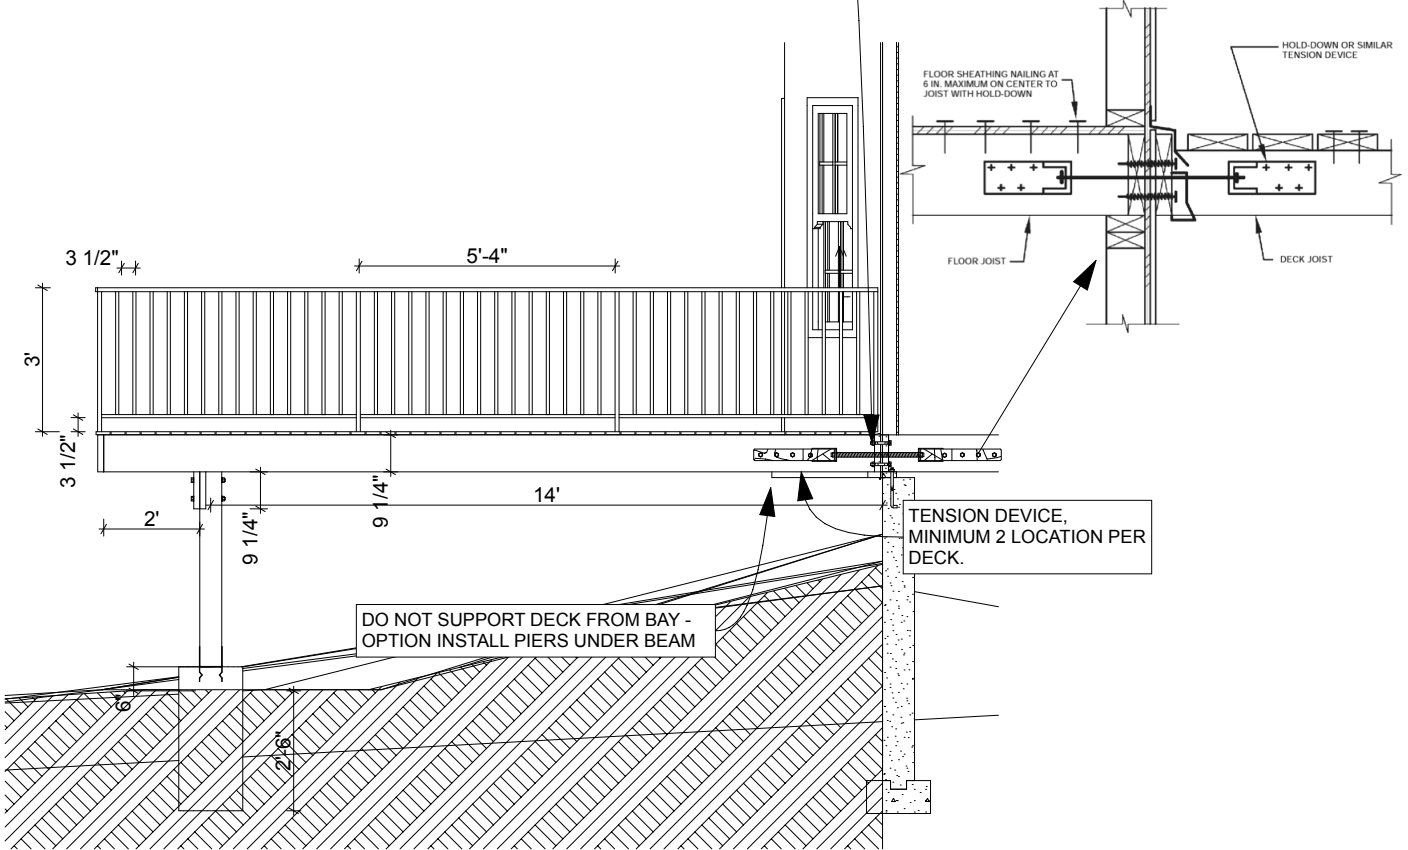


S-01

Building Section

1/4" = 1'-0"

2 OF 6


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	Checked by <b>DECK EXAMPLE # 2</b>	Date	Drawing Status <b>DECK EXAMPLE</b>
<b>Project</b> #Architect Address1 #Architect City #Architect Country #Architect Postcode	Drawing Scale <b>1/4" = 1'-0"</b>		Drawing ID      Status      Revision <b>A.03.1</b>

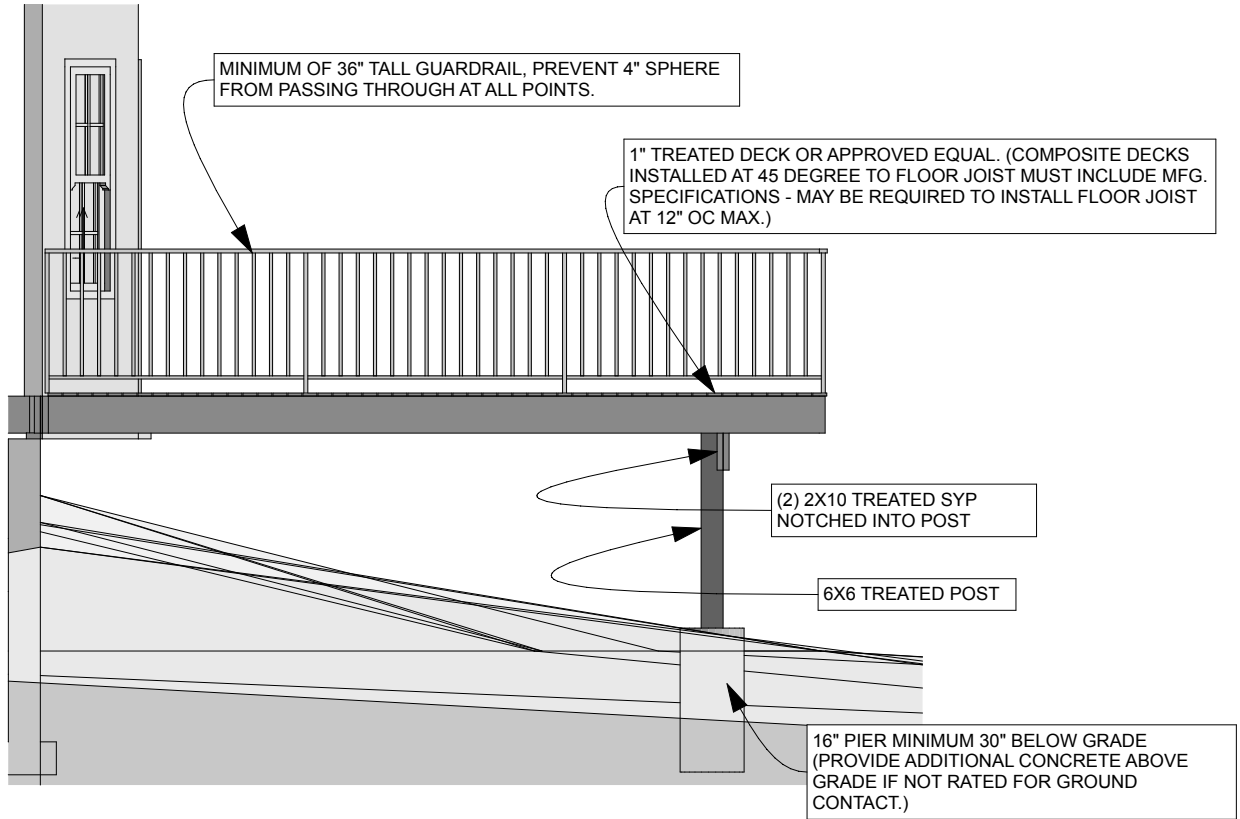

East Elevation      1/4" = 1'-0"

<b>Company name</b> Street City State/Country Postal Code	Drawn by <b>EXAMPLE ONLY NOT FOR CONSTRUCTION</b>	Date	Drawing Name <b>East Elevation</b>
	Checked by <b>DECK EXAMPLE # 2</b>	Date	Drawing Status <b>DECK EXAMPLE</b>
<b>Project</b> #Architect Address1 #Architect City #Architect Country #Architect Postcode			Drawing Scale <b>1/4" = 1'-0"</b>
			Layout ID      Status      Revision <b>A.04.1</b>


EXISTING SLIDING DOOR (NO CHANGE) (MUST HAVE LIGHT AND WP / GFCI INSTALLED TO SERVE DECK)

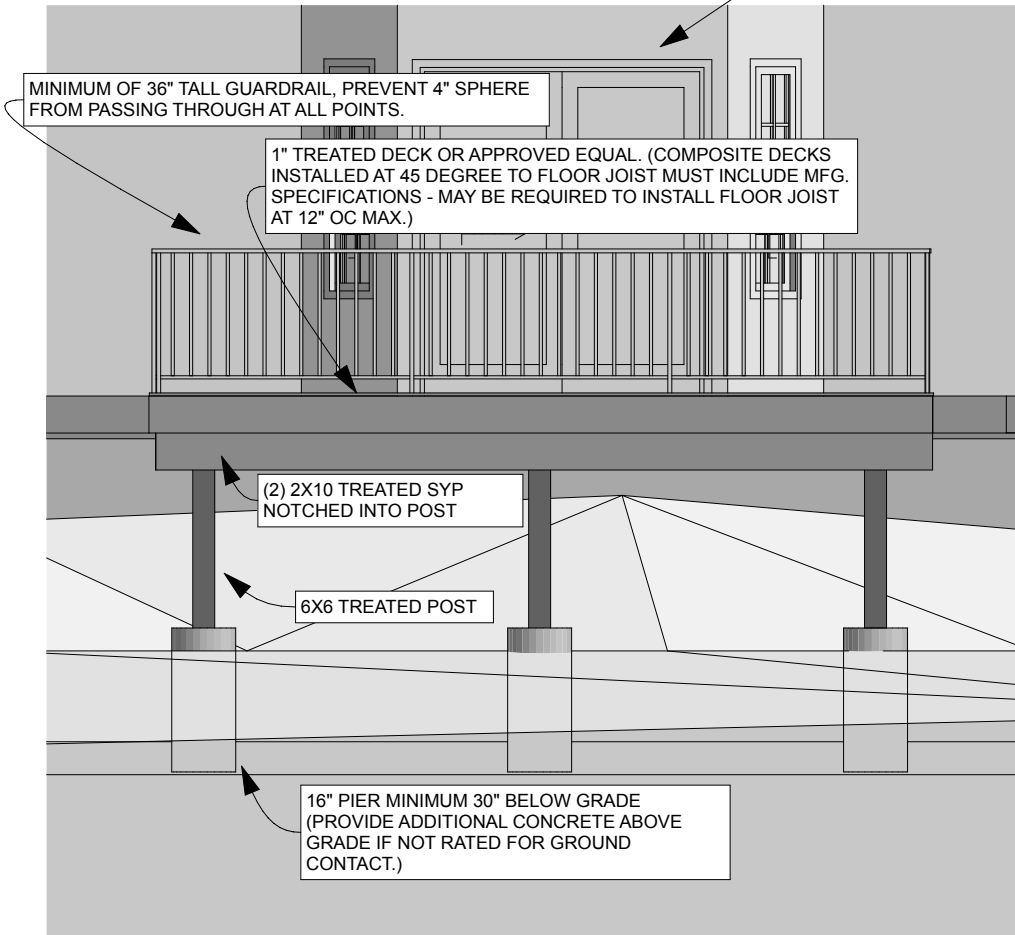

North Elevation

1/4" = 1'-0"

<b>Company name</b> Street City State/Country Postal Code	Drawn by <b>EXAMPLE ONLY NOT FOR CONSTRUCTION</b>	Date	Drawing Name <b>North Elevation</b>
	Checked by <b>DECK EXAMPLE # 2</b>	Date	Drawing Status <b>DECK EXAMPLE</b>
<b>Project</b> #Architect Address1 #Architect City #Architect Country #Architect Postcode			Drawing Scale <b>1/4" = 1'-0"</b>
			Layout ID      Status      Revision <b>A.04.2</b>

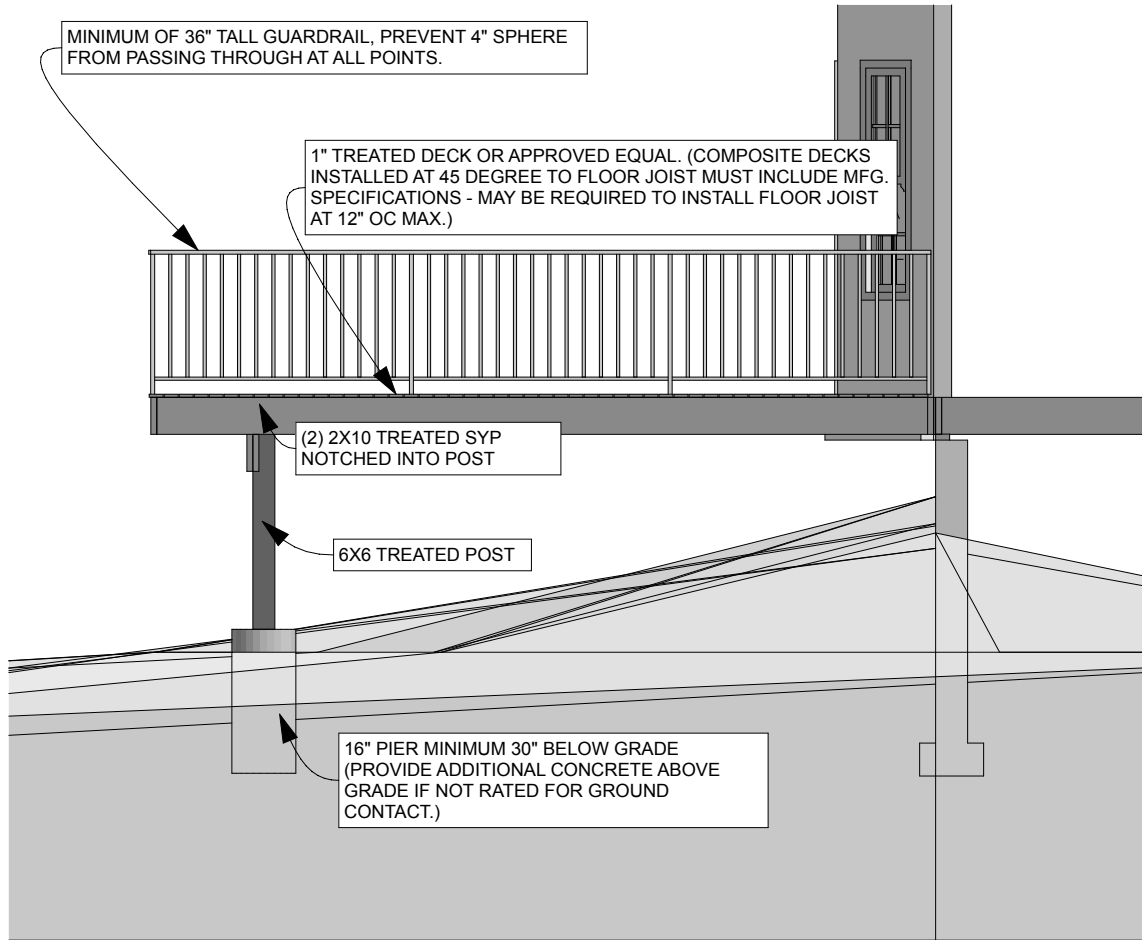

West Elevation

1/4" = 1'-0"  
5 OF 6

<b>Company name</b> Street City State/Country Postal Code	Drawn by <b>EXAMPLE ONLY NOT FOR CONSTRUCTION</b>	Date	Drawing Name <b>West Elevation</b>
	Checked by <b>DECK EXAMPLE # 2</b>	Date	Drawing Status <b>DECK EXAMPLE</b>
<b>Project</b> #Architect Address1 #Architect City #Architect Country #Architect Postcode			Drawing Scale <b>1/4" = 1'-0"</b>
			Layout ID                      Status                      Revision <b>A.04.3</b>

